



PERSPECTIVE




FRONT VIEW




SIDE VIEW




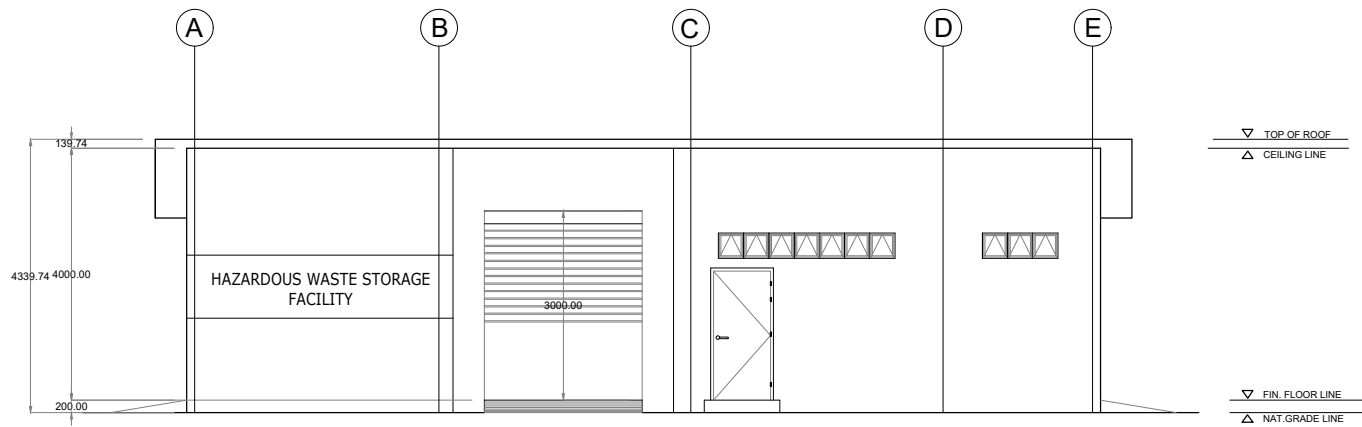
SIDE VIEW

| | | | | | | |
|---|---|---|---------------------------------|---|----------------|-----------|
|  <p>SOUTHERN LEYTE STATE UNIVERSITY SOGOD, SOUTHERN LEYTE www.slsuonline.edu.ph email: slsumaincampus@gmail.com telephone: (053)977-4209</p> | PREPARED BY: | PROJECT TITLE: | OWNER: | APPROVED AS PER PLAN: | SHEET CONTENT: | SHEET NO: |
| | <u>AR. SARAH JANE G. HERNANI, uap</u> ARCHITECT | PROPOSED HAZARDOUS WASTE STORAGE FACILITY AT SOGOD CAMPUS | SOUTHERN LEYTE STATE UNIVERSITY | <u>PROSE IVY G. YEPES, Ed.D</u> UNIVERSITY PRESIDENT | AS SHOWN | A-01 |
| | LOCATION: SLSU-MAIN CAMPUS, SAN ROQUE, SOGOD SOUTHERN LEYTE | ADDRESS: SOGOD SOUTHERN LEYTE | CHECKED: | DRAWN: | SCALE: | |
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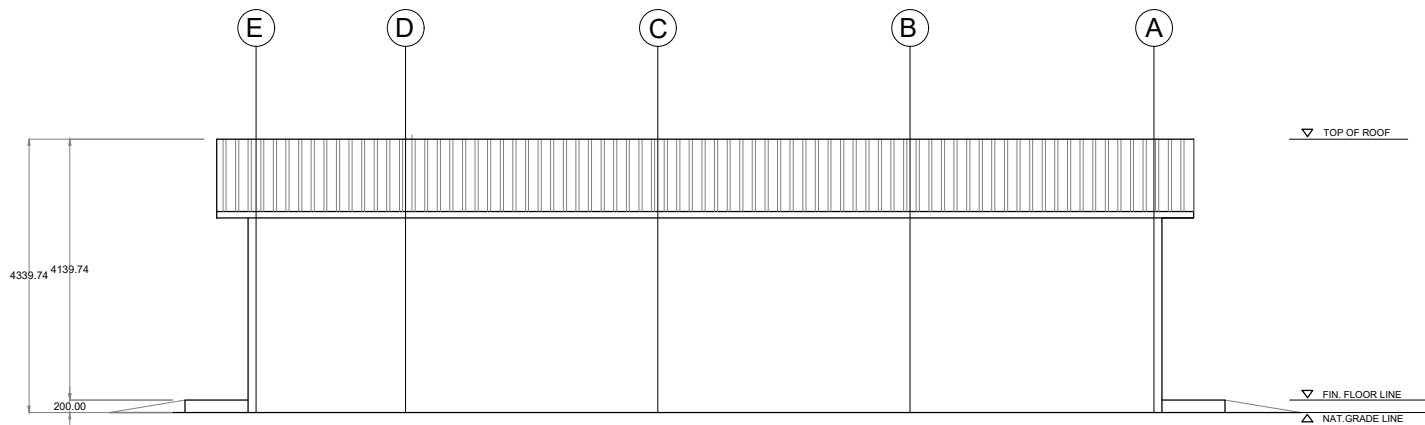


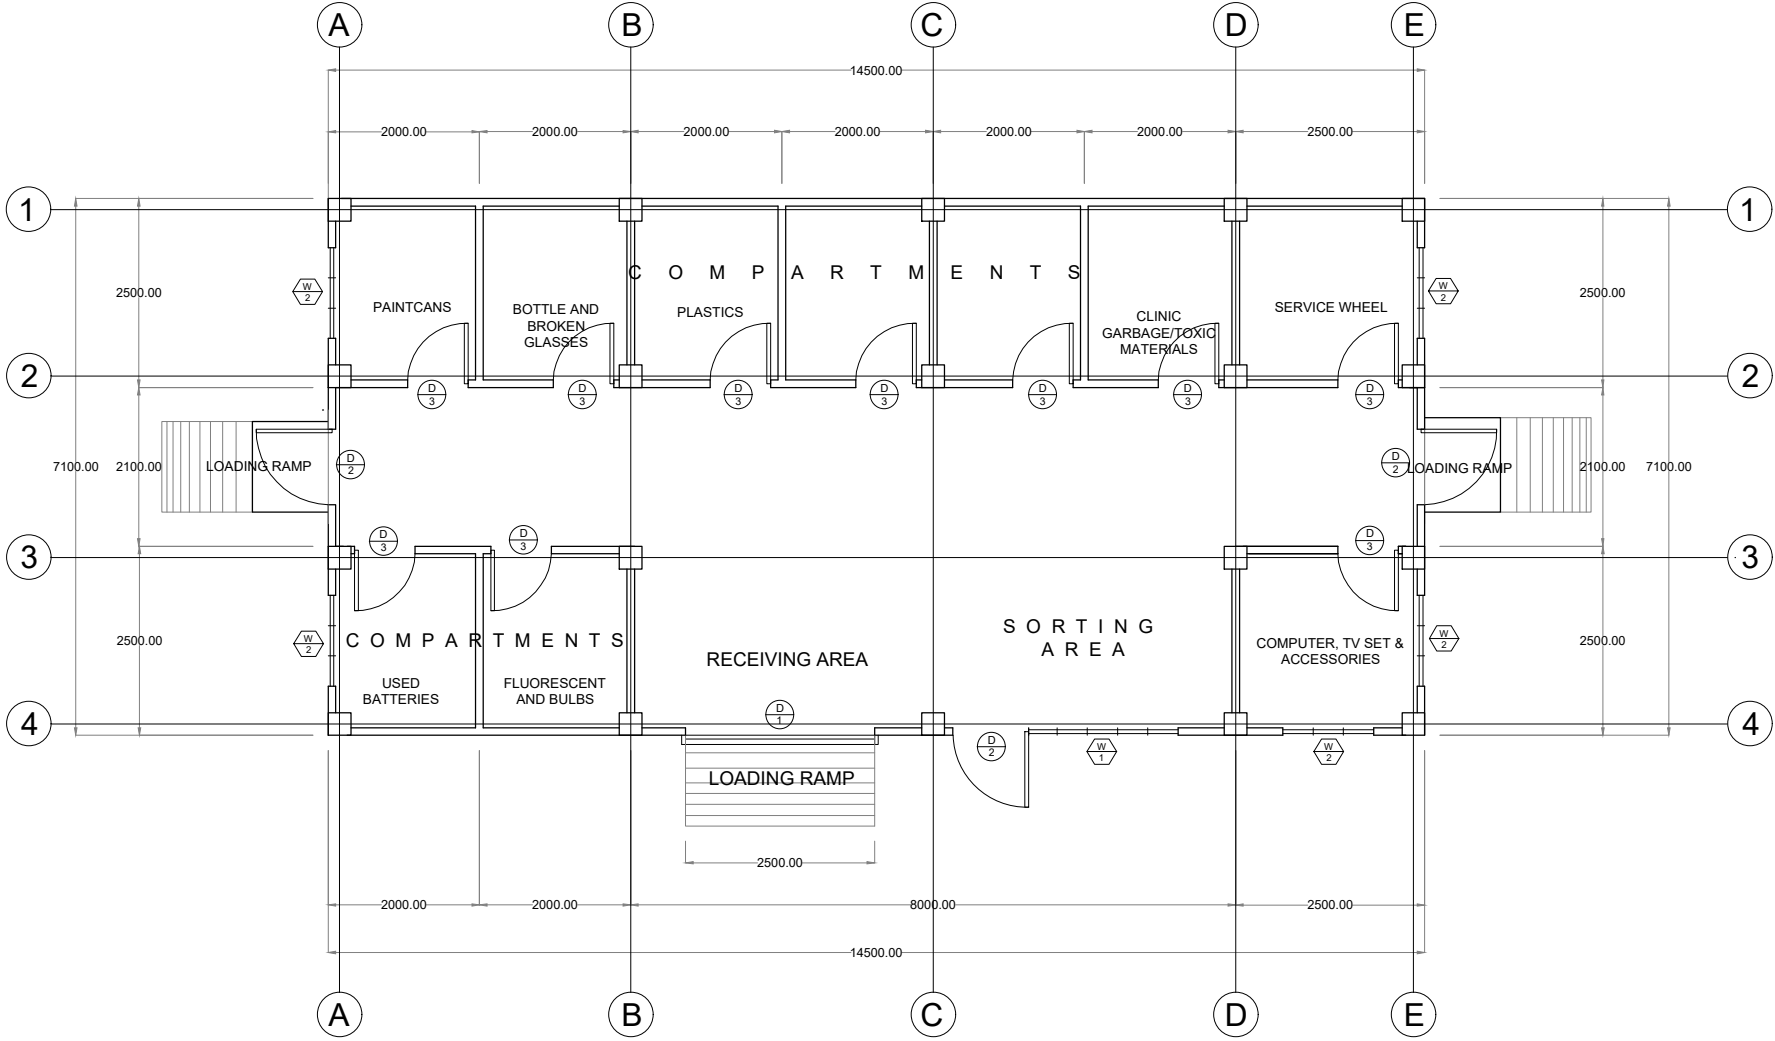A FLOOR PLAN
A-02 SCALE: 1:100 MTS


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|  | SOUTHERN LEYTE STATE UNIVERSITY SOGOD, SOUTHERN LEYTE <small>www.slsuonline.edu.ph email: slsunmaincampus@gmail.com telephone: (053)977-4269</small> | PREPARED BY: <u>AR. SARAH JANE G. HERNANI, uap</u> ARCHITECT | PROJECT TITLE: PROPOSED HAZARDOUS WASTE STORAGE FACILITY AT SOGOD CAMPUS <small>LOCATION: SLSU-MAIN CAMPUS, SAN ROQUE, SOGOD SOUTHERN LEYTE</small> | OWNER: SOUTHERN LEYTE STATE UNIVERSITY <small>ADDRESS: SOGOD SOUTHERN LEYTE</small> | APPROVED AS PER PLAN: <u>PROSE IVY G. YEPES, Ed.D</u> UNIVERSITY PRESIDENT | SHEET CONTENT: AS SHOWN <small>CHECKED: _____ DRAWN: _____ SCALE: _____ APPROVED: _____ DATE: _____ AS SHOWN</small> | SHEET NO: A-02 |
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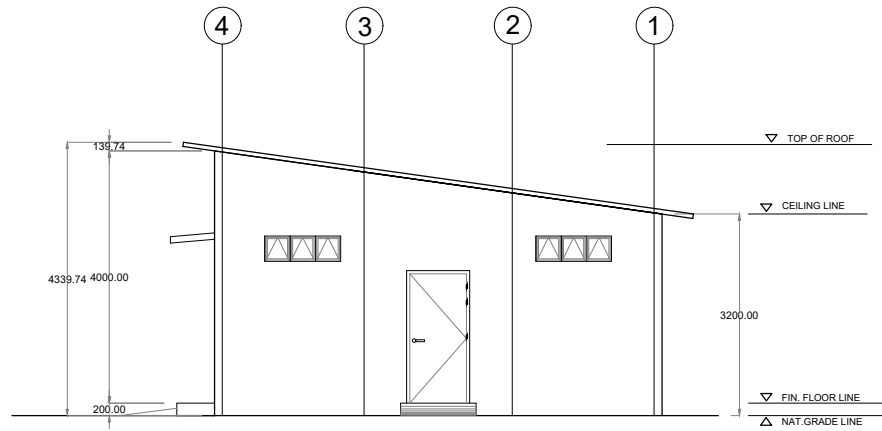


A FRONT ELEVATION
A-03 SCALE: 1:120 MTS




B REAR ELEVATION
A-03 SCALE: 1:120 MTS


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| | AR. SARAH JANE G. HERNANI, uap ARCHITECT | PROPOSED HAZARDOUS WASTE STORAGE FACILITY AT SOGOD CAMPUS | SOUTHERN LEYTE STATE UNIVERSITY | PROSE IVY G. YEPES, Ed.D UNIVERSITY PRESIDENT | AS SHOWN | A-03 |
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A RIGHT-SIDE ELEVATION
A-04 SCALE: 1:120 MTS




B LEFT-SIDE ELEVATION
A-04 SCALE: 1:120 MTS

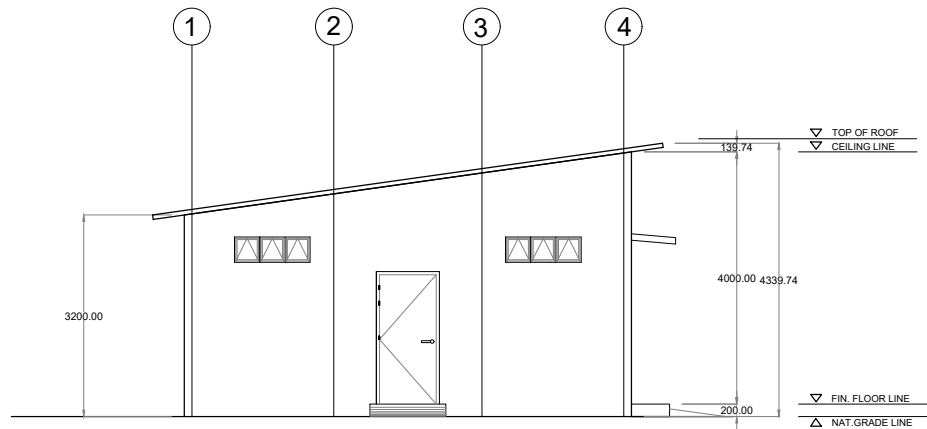
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|  <p>SOUTHERN LEYTE STATE UNIVERSITY SOGOD, SOUTHERN LEYTE www.slsuonline.edu.ph email: slsumaincampus@gmail.com tel/fax: (053) 377-4299</p> | PREPARED BY: | PROJECT TITLE: | OWNER: | APPROVED AS PER PLAN: | SHEET CONTENT: | SHEET NO: |
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| | LOCATION: SLSU-MAIN CAMPUS, SAN ROQUE, SOGOD SOUTHERN LEYTE | ADDRESS: SOGOD SOUTHERN LEYTE | CHECKED: _____ DRAWN: _____ APPROVED: _____ DATE: _____ | SCALE: AS SHOWN | | |

| | | | |
|----------------------------|-----------|---|---|
| SCHEDULE OF WINDOWS | PLAN | | |
| | ELEVATION | | |
| MARK | | | |
| LOCATION | | AS SHOWN IN THE PLAN | AS SHOWN IN THE PLAN |
| QUANTITY | | 1 SET | 5 SETS |
| SPECIFICATION | | 1 1/4" x 4" POWDER COATED FRAME & JAMB AWNING WINDOW USING 1/4" THICK TINTED GLASS. | 1 1/4" x 4" POWDER COATED FRAME & JAMB AWNING WINDOW USING 1/4" THICK TINTED GLASS. |

| | | | | |
|--------------------------|-----------|-----------------------|--|--|
| SCHEDULE OF DOORS | PLAN | | | |
| | ELEVATION | | | |
| MARK | | | | |
| LOCATION | | AS SHOWN IN THE PLAN | AS SHOWN IN THE PLAN | AS SHOWN IN THE PLAN |
| QUANTITY | | 1 SET | 3 SET | 10 SETS |
| SPECIFICATION | | ALUMINUM ROLL-UP DOOR | FLUSH DOOR WITH STAINLESS STEEL LIVER TYPE LOCKSET | FLUSH DOOR WITH STAINLESS STEEL LIVER TYPE LOCKSET |

SCHEDULE OF DOORS AND WINDOWS

| | | | | | | | |
|--|---|--|---------------------------------|---|-----------------------------------|-----------------------------|--------------------------|
|  SOUTHERN LEYTE STATE UNIVERSITY SOGOD, SOUTHERN LEYTE <small>www.slsuonline.edu.ph email: slsumaincampus@gmail.com telephone: (053)977-4009</small> | PREPARED BY: | PROJECT TITLE: | OWNER: | APPROVED AS PER PLAN: | SHEET CONTENT: | SHEET NO: | |
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| | LOCATION: SLSU-MAIN CAMPUS, SAN ROQUE, SOGOD SOUTHERN LEYTE | ADDRESS: SOGOD SOUTHERN LEYTE | | | CHECKED: _____ APPROVED: _____ | DRAWN: _____ DATE: _____ | SCALE: _____ AS SHOWN |

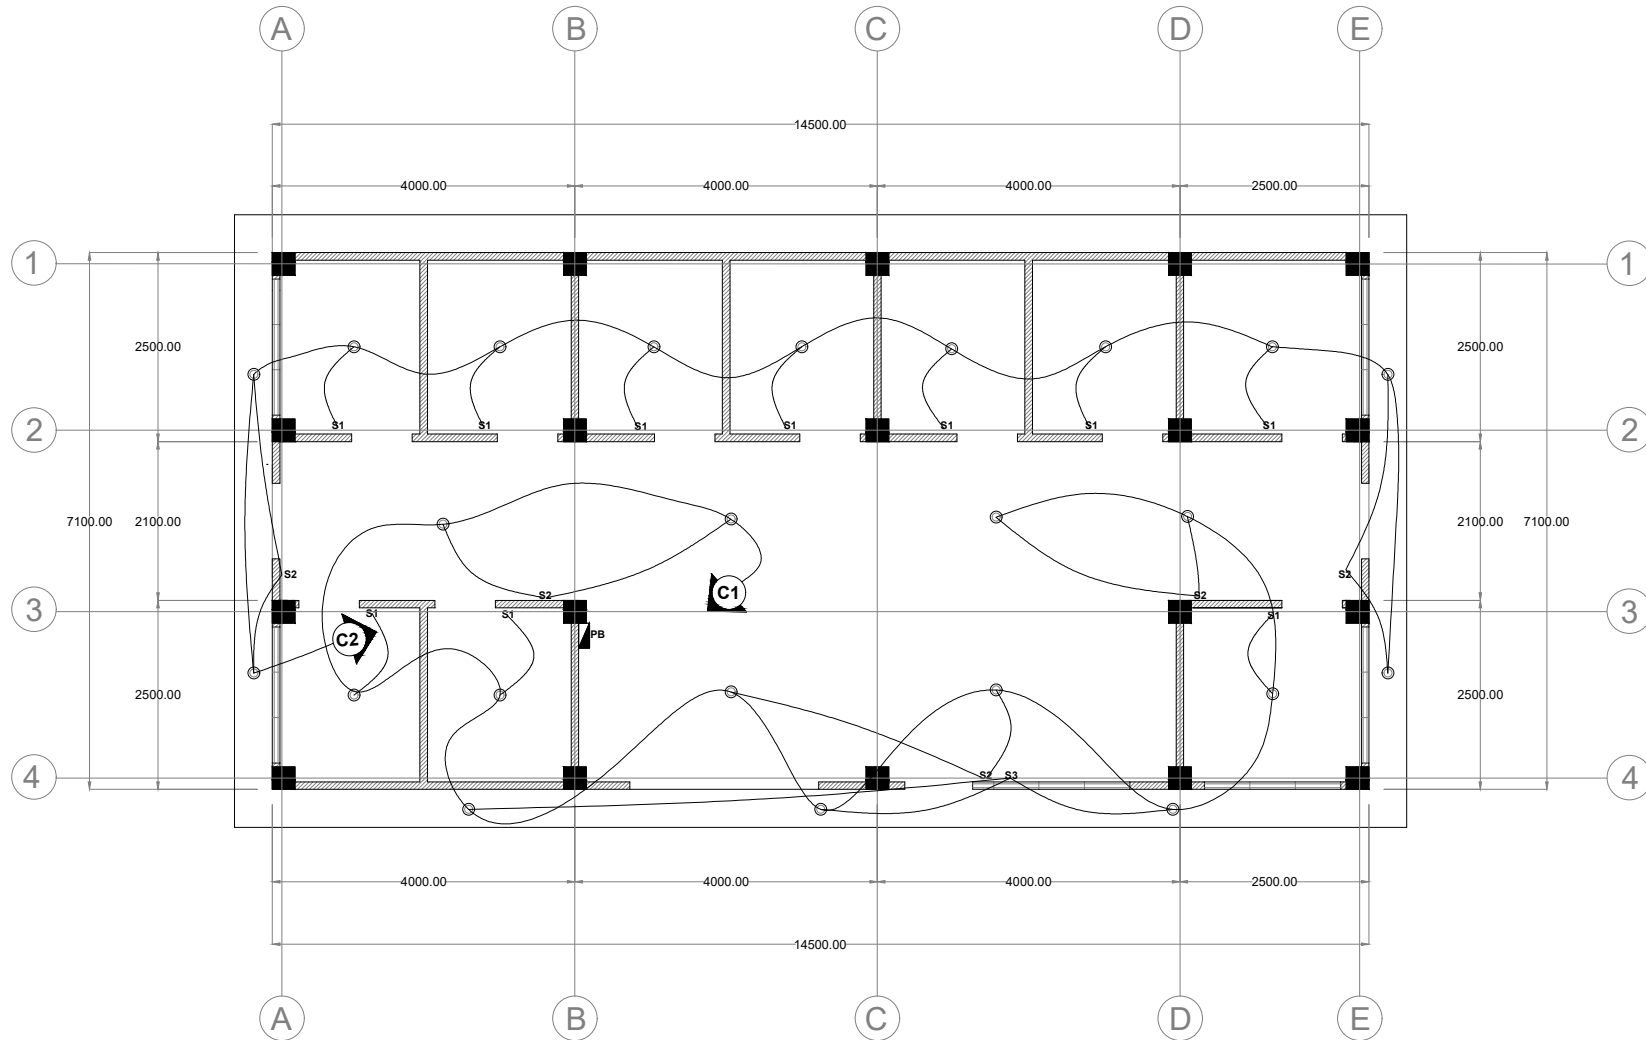

A LIGHTING LAYOUT PLAN
E-01 SCALE: 1:100 MTS



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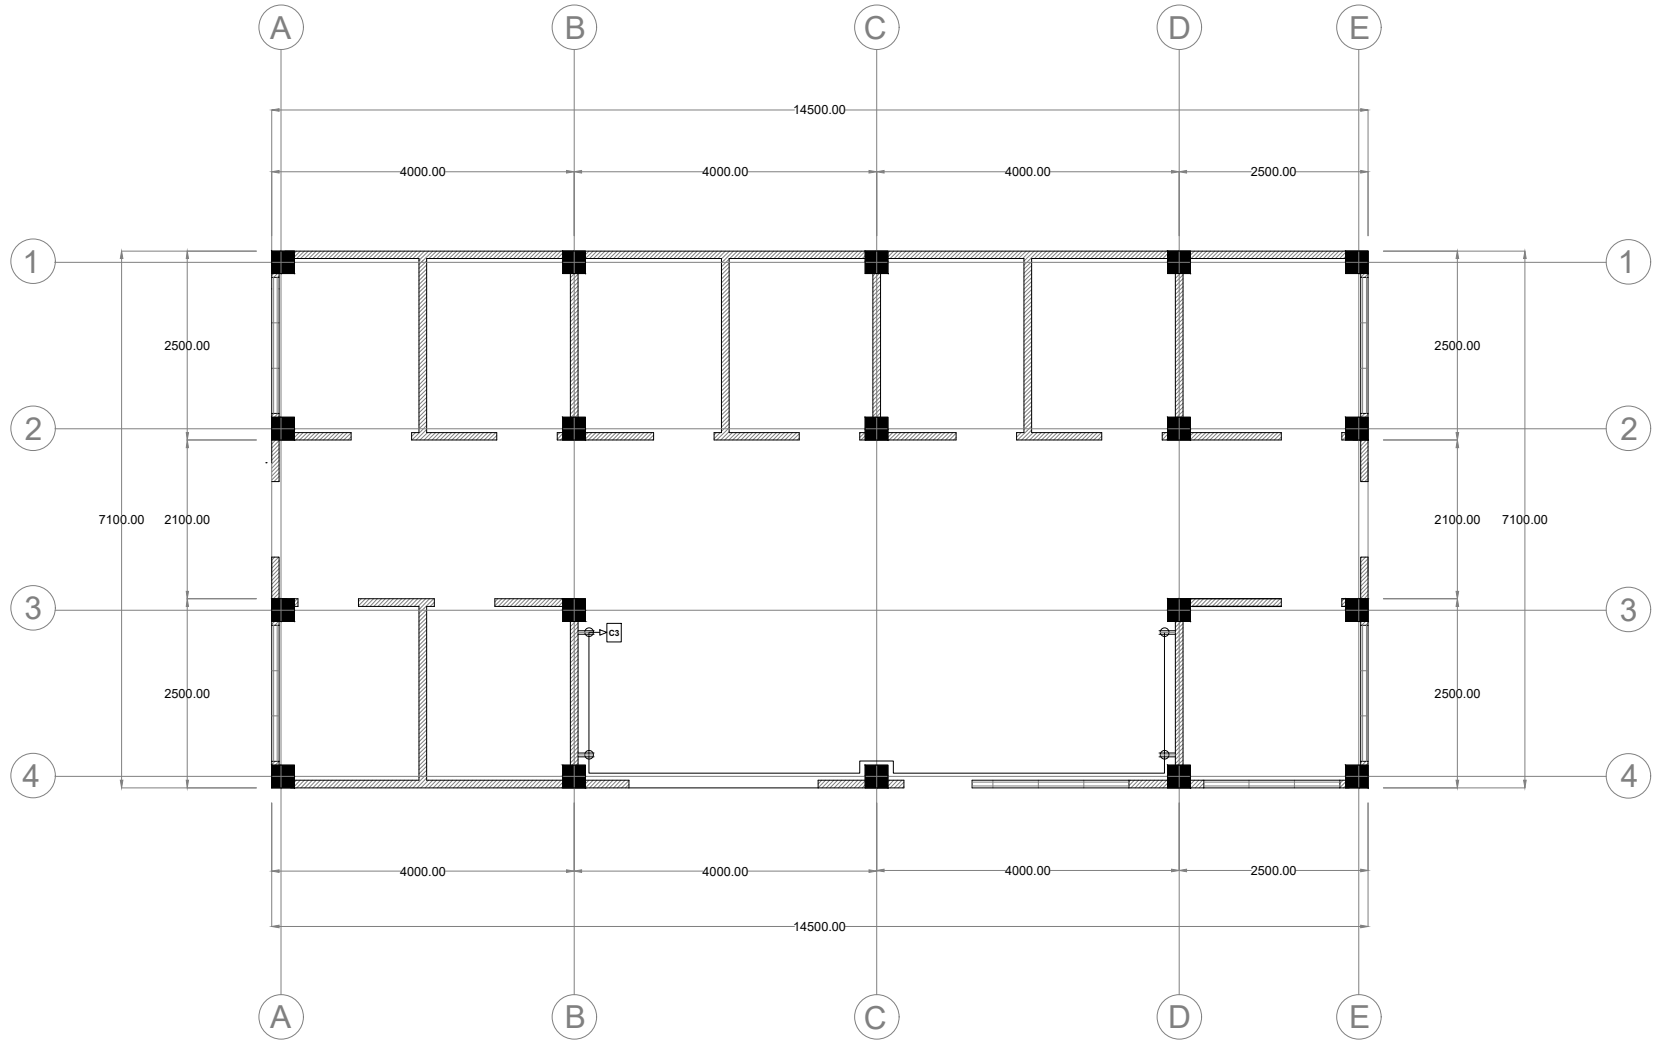
PROJECT TITLE:
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 LOCATION: SLSU-MAIN CAMPUS, SAN ROQUE, SOGOD SOUTHERN LEYTE

OWNER:
SOUTHERN LEYTE STATE UNIVERSITY
 ADDRESS: SOGOD SOUTHERN LEYTE

APPROVED AS PER PLAN:
PROSE IVY G. YEPES, Ed.D
 UNIVERSITY PRESIDENT

SHEET CONTENT:
 AS SHOWN
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SHEET NO:
 E-01



A POWER LAYOUT PLAN
E-02 SCALE: 1:100 MTS



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 LOCATION: SLSU-MAIN CAMPUS, SAN ROQUE, SOGOD SOUTHERN LEYTE

OWNER:
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 ADDRESS: SOGOD SOUTHERN LEYTE

APPROVED AS PER PLAN:
PROSE IVY G. YEPES, Ed.D
 UNIVERSITY PRESIDENT

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 AS SHOWN
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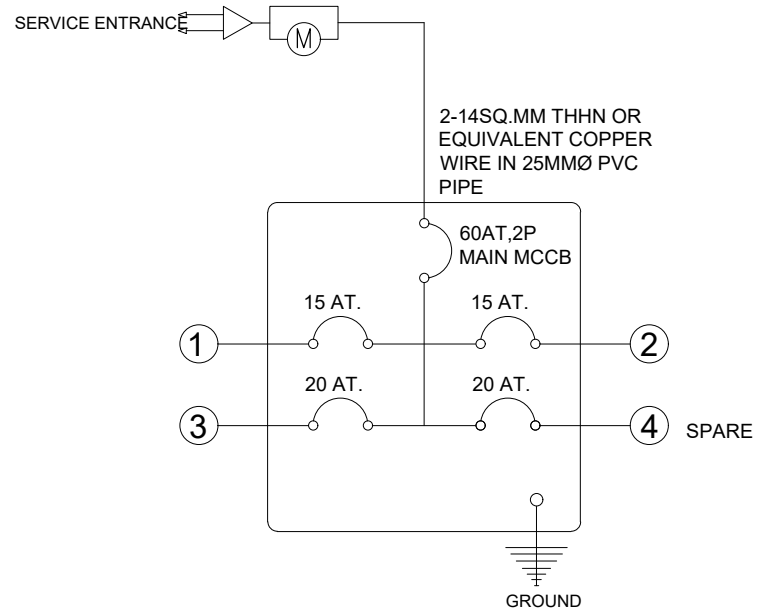
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 E-02

GENERAL NOTES


- ALL ELECTRICAL WORKS AND INSTALLATION HEREIN, SHALL BE DONE IN ACCORDANCE WITH THE PROVISION OF THE LATEST EDITION OF THE PHILIPPINE ELECTRICAL CODE, REQUIREMENTS OF THE LOCAL POWER COMPANY, RULES AND REGULATIONS OF THE LOCAL ENFORCING AUTHORITIES.
- ALL ELECTRICAL WORKS HEREIN SHALL BE EXECUTE BY EXPERIENCED MEN UNDER THE DIRECT SUPERVISION OF DULY REGISTERED MASTER ELECTRICIAN OR ELECTRICAL ENGINEER.
- THE CONTRACTOR SHALL VERIFY AND ORIENT THE ACTUAL LOCATION OF SERVICE ENTRANCE FOR CONNECTION TO POWER SUPPLY.
- THE TYPE OF POWER TO BE SUPPLIED SHALL BE, 220VAC, SINGLE PHASE, TWO WIRE PLUS GROUND, 60 HERTZ.
- UNLESS OTHERWISE SPECIFIED, THE MINIMUM SIZE OF WIRE SHALL BE 3.5 SQMM THHN/THWN AND THE CONDUIT SHALL BE 15 mmØ RSC AND 20 mmØ uPVC.
- ALL MATERIALS TO BE USED SHALL BE NEW AND OF THE APPROVED TYPE FOR THE LOCATION AND PURPOSE.
- UNLESS OTHERWISE INDICATE ON THE DRAWING, POLYVINYL CHLORIDE (PVC) CONDUIT SHALL BE USED FOR EMBEDDED WIRING AND RIGID STEEL CONDUIT (RSC) FOR EXPOSED WIRING.
- ALL WIRE SHALL BE COPPER AND THERMOPLASTIC INSULATED TYPE "THHN/THWN" UNLESS OTHERWISE INDICATED IN THE PLANS. THE MINIMUM SIZE FOR POWER AND LIGHTING SHALL BE 3.5sqmm AND SHALL BE MANUFACTURED BY PHELPS DODGE OR DURAFLEX OR WITH ISO CERTIFICATES.
- ALL CIRCUIT BOXES SHALL BE GALVANIZED GAGE NO. 16, DEEP TYPE WITH FACTORY KNOCKOUTS .
- THE CIRCUIT BREAKERS SHALL BE WITH ISO CERTIFICATES AND SHALL BE BOLT-ON TYPE WITH UL LISTED ENCLUSURE.
- ALL MOUNTING HEIGHTS ARE SUBJECT TO ENGINEER'S APPROVAL PRIOR TO INSTALLATION.
- PROVIDE GROUND FAULT CIRCUIT INTERRUPTER (GFCI) FOR ALL CONVENIENCE OUTLET LOCATED IN THE LAUNDRY AREA OR IN OUTDOOR USE AS WELL AS IN THE LAVATORY COUNTER AREA.
- CONDUCT INSULATION RESISTANCE TEST PRIOR FOR TERMINATION OF DEVICES AS WELL AS OTHER NECESSARY ELECTRICAL TESTING STANDARDS.
- SWITCHES SHALL BE FLUSH MOUNTED AND LOCATED 200mm FROM THE EDGE OF THE DOOR JAMP TO THE CENTER OF THE SWITCH OR 150mm FROM THE EDGE OF THE DOOR JAMP TO THE EDGE OF THE SWITCH.
- NO REVISION IN THE DESIGN SHALL BE DONE WITHOUT PRIOR KNOWLEDGE AND APPROVAL OF THE DESIGNER.
- CONTRACTOR WILL PROVIDE THE OWNER WITH TWO(2) SETS OF AS-BUILT PLANS WITH E-FILE AND DULY SIGNED BY THEIR REGISTERED LICENSED ELECTRICAL ENGINEER.


SCHEDULE OF LOADS

| CKT.NO. | LOAD DESCRIPTION | OUTLET SWITCHES | | | | | | PHASE | PHASE | VOLT | WATTS | AMPS. | CIRCUIT BREAKER | SIZE OF WIRE & CONDUIT |
|---------|--------------------|-----------------|-----|----|----|----|-----|-------|-------|------|-------|-------|-----------------|---------------------------|
| | | L.O | C.O | S1 | S2 | S3 | S3W | | | | | | | |
| 1 | LIGHTING OUTLET | 12 | | 3 | 3 | 1 | | 1 | 1 | 220 | 20 | 1.09 | 15AT, 15AF, 2P | NO. 14 AWG. STRANDED WIRE |
| 2 | LIGHTING OUTLET | 11 | | 7 | 2 | | | 1 | 1 | 220 | 20 | 1 | 15AT, 15AF, 2P | NO. 14 AWG. STRANDED WIRE |
| 3 | CONVENIENCE OUTLET | | 4 | | | | | 1 | 1 | 220 | 360 | 6.55 | 20AT, 20AF, 2P | NO. 12 AWG. STRANDED WIRE |
| 4 | SPARE | | | | | | | | | | | | SPARE | |
| TOTAL | | 23 | 4 | | | | | | | | | 8.64 | | |




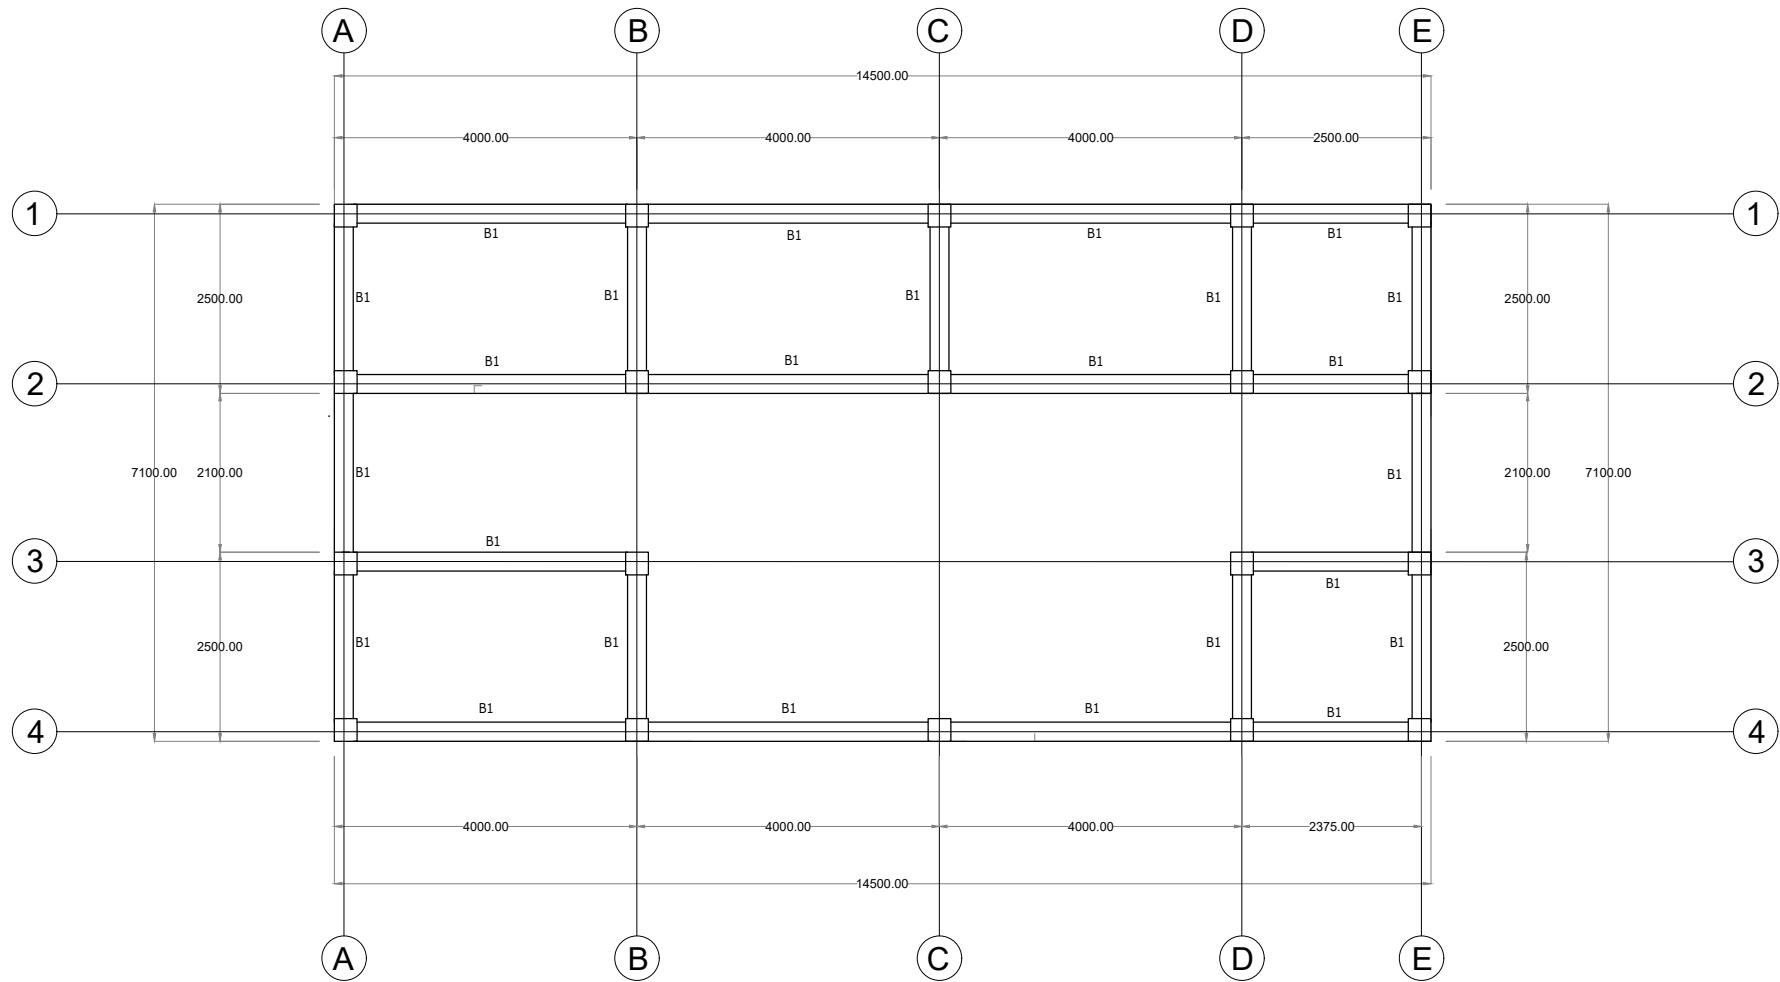
SINGLE LINE DIAGRAM

| | | | | | | | | | | | | |
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| LOCATION: SLSU-MAIN CAMPUS, SAN ROQUE, SOGOD SOUTHERN LEYTE | | ADDRESS: SOGOD SOUTHERN LEYTE | | <table border="1"> <tr> <td>CHECKED:</td> <td>DRAWN:</td> <td>SCALE:</td> </tr> <tr> <td>APPROVED:</td> <td>DATE:</td> <td>AS SHOWN</td> </tr> </table> | | CHECKED: | DRAWN: | SCALE: | APPROVED: | DATE: | AS SHOWN | |
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| APPROVED: | DATE: | AS SHOWN | | | | | | | | | | |

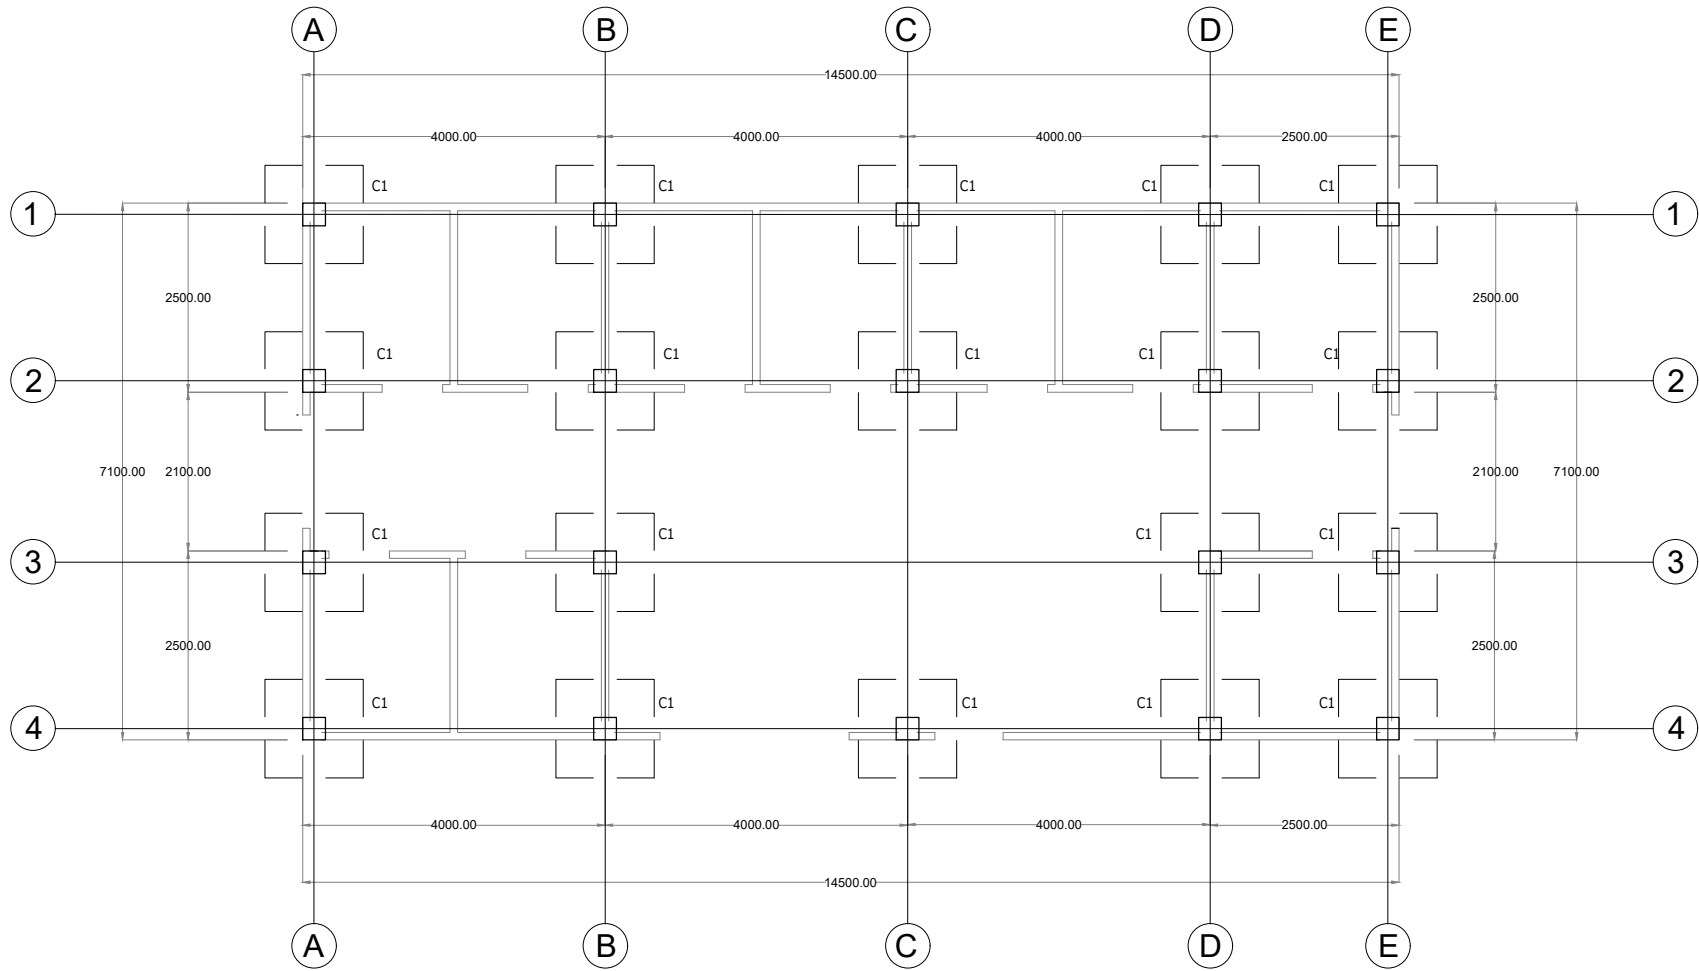

A FOUNDATION PLAN
S-01 SCALE: 1:100 MTS

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|--|--|--|---|--|----------------------------|-------------------|
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A
S-02

BEAM LAYOUT PLAN

SCALE: 1:100 MTS



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AR. SARAH JANE G. HERNANI, uap
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PROJECT TITLE:

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LOCATION: SLSU-MAIN CAMPUS, SAN ROQUE, SOGOD SOUTHERN LEYTE

OWNER:

SOUTHERN LEYTE STATE UNIVERSITY

ADDRESS: SOGOD SOUTHERN LEYTE

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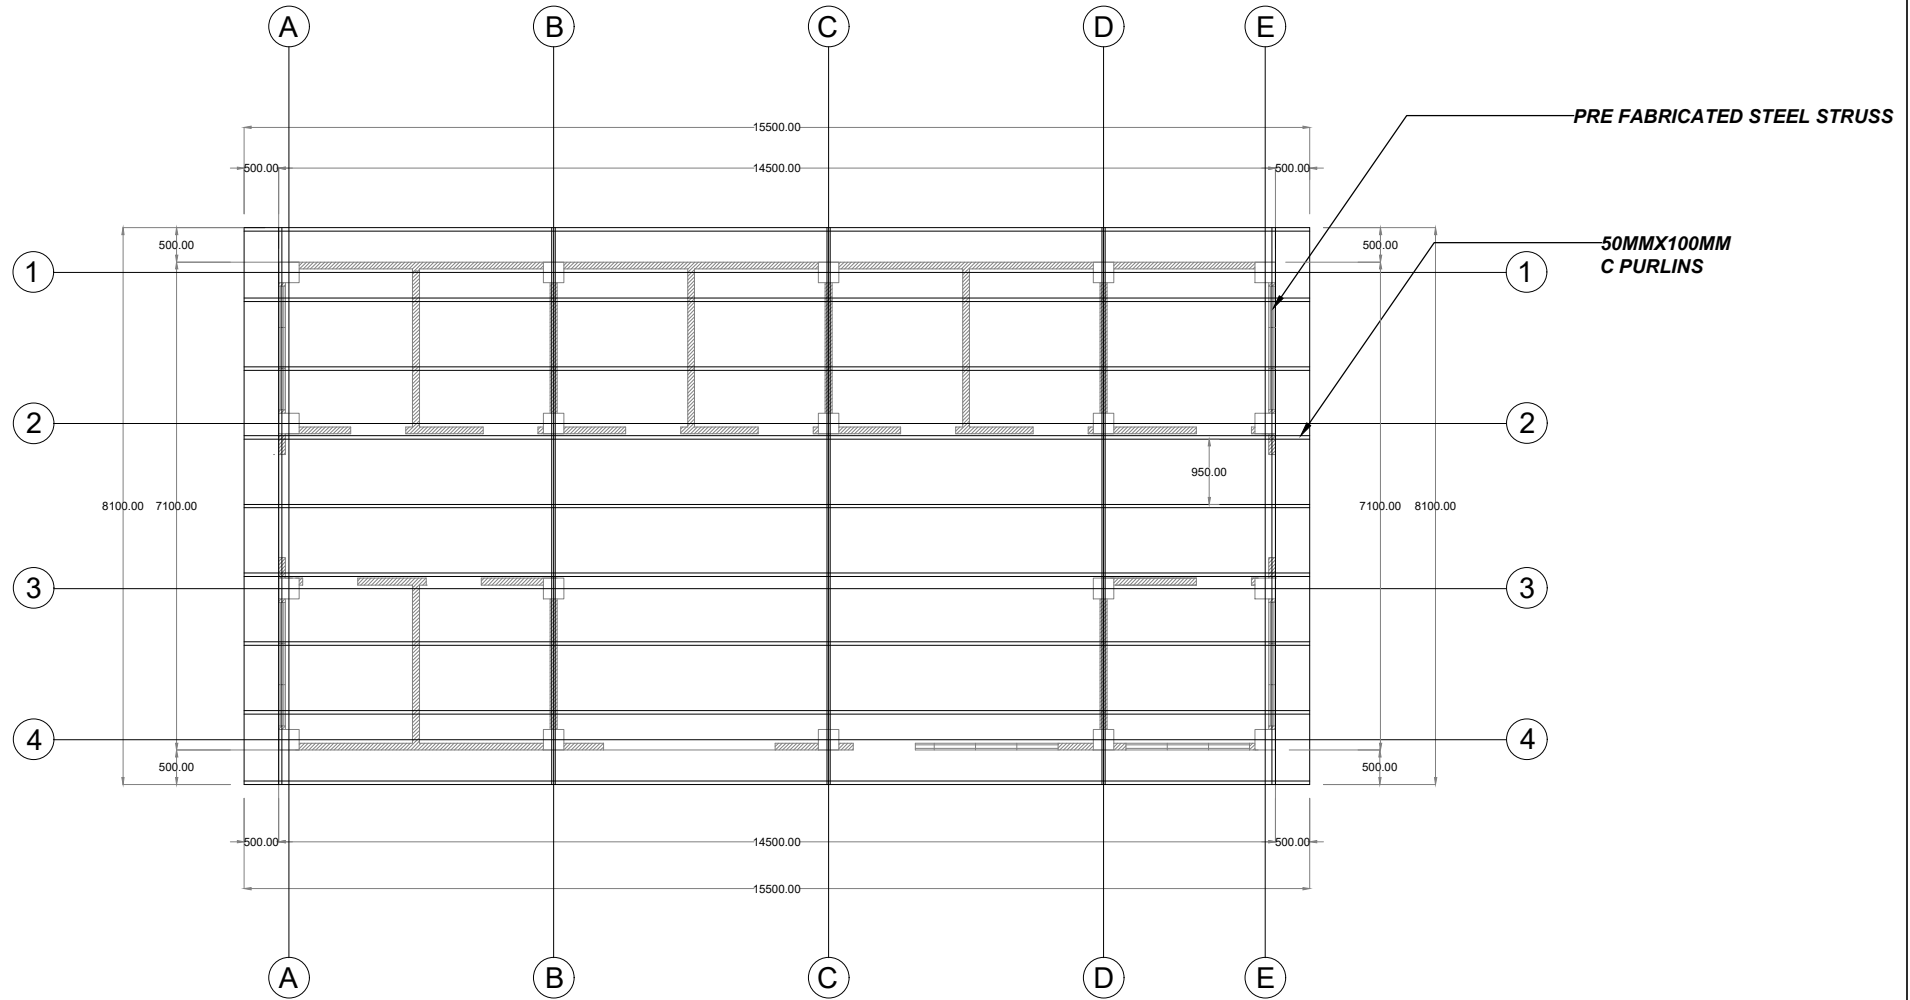
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
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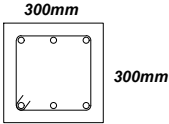
S-02




A ROOF FRAMING PLAN
S-03 SCALE: 1:110 MTS

| | | | | | | |
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SCHEDULE OF REINFORCED CONCRETE COLUMNS

| MARK | FOUNDATION TO SECOND FLOOR BEAM |
|------------|---|
| C1 |  |
| SIZE | 300 mm x 300 mm |
| VERT. BARS | 9 - 20MMØ |
| TIES | 12@0.05, 12MMØ, 10@0.10, 12MMØ |
| | REST @ 0.15M |

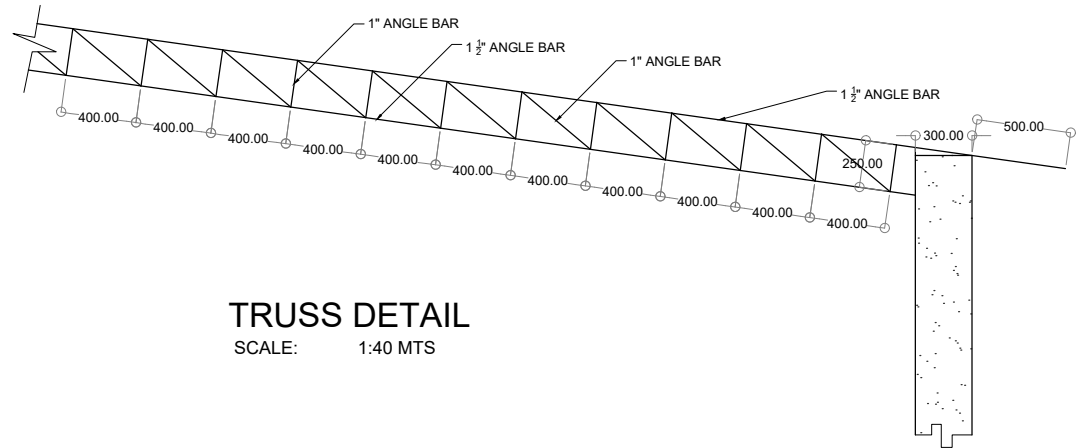

TRUSS DETAIL
SCALE: 1:40 MTS

SCHEDULE OF FOOTINGS

| MARK | FOOTING DIMENSIONS | | | EMBEDMENT DEPTH (m) (FROM NGL) | TOP BARS | | BOTTOM BARS | | REMARKS |
|------|--------------------|------------------|--------------------|--------------------------------------|------------------------|-------------------------|------------------------|-------------------------|------------------|
| | WIDTH, B (m) | LENGTH, L (m) | THICKNESS t (m) | | BARS ALONG WIDTH, B | BARS ALONG LENGTH, L | BARS ALONG WIDTH, B | BARS ALONG LENGTH, L | |
| F1 | 1.20 | 1.20 | 0.30 | 2.00 | NONE | NONE | 9 - 16MM Ø | 9 - 16MM Ø | ISOLATED FOOTING |

MATERIAL SPECIFICATIONS:

$f_c' = 21 \text{ MPa (3,000 psi)}$
 $f_y = 276 \text{ MPa (40,000 psi)}$ FOR 12MMØ BARS AND BELOW
 $f_y = 414 \text{ MPa (60,000 psi)}$ FOR 16MMØ BARS AND ABOVE

ALLOWABLE SOIL PRESSURE:

$q_a = 144 \text{ kPa (3,000 psf)}$

SCHEDULE OF BEAMS

| BEAM MARK | DIMENSION BxD (m.) | LEFT SUPPORT | | MIDSPAN | | RIGHT SUPPORT | | STIRRUPS |
|--------------|-----------------------|--------------|-----------|----------|-----------|---------------|-----------|--|
| | | TOP BARS | BOT. BARS | TOP BARS | BOT. BARS | TOP BARS | BOT. BARS | |
| BEAM | | | | | | | | |
| B-1 | 0.20 x 0.30 | 3-20mm | 2-20mm | 2-20mm | 3-20mm | 3-20mm | 2-20mm | 12mmØ STIRRUPS 4 @ 0.05, 5 @ 0.10, REST @ 0.15m O.C. |



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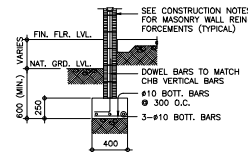
SHEET NO:

S-04

GENERAL CONSTRUCTION NOTES

REINFORCING CONCRETE LINTEL BEAM IN CONCRETE BLOCK WALLS

| CLEAR SPAN (L) (M) | TOTAL LENGTH (L+4D) (M) | MIN. LINTEL HEIGHT (H) (M) | REINFORCEMENT | | |
|--------------------|-------------------------|----------------------------|---------------|-------|---------------|
| | | | BOTTOM | TOP | STIRRUPS |
| 1.50M | 1.50M | 200 | 1-#10 | 1-#10 | #6mm @ 200mm |
| 1.50M | 1.90M | 200 | 1-#10 | 1-#10 | #6mm @ 200mm |
| 1.50M | 2.20M | 200 | 1-#12 | 1-#10 | #6mm @ 200mm |
| 2.10M | 2.50M | 250 | 1-#12 | 1-#10 | #6mm @ 200mm |
| 2.40M | 2.80M | 250 | 1-#12 | 1-#10 | #6mm @ 200mm |
| 2.70M | 3.10M | 250 | 1-#16 | 1-#12 | #10mm @ 200mm |
| 3.00 | 3.40M | 300 | 1-#16 | 1-#12 | #10mm @ 200mm |
| 3.30 | 3.70M | 300 | 1-#16 | 1-#12 | #10mm @ 200mm |
| 3.60 | 4.00 | 300 | 1-#20 | 1-#12 | #10mm @ 200mm |



TYPICAL CONNECTION DETAIL OF R.C. WALL AT CORNERS

NOTES OF STIRRUPS

- ALL REINFORCEMENT SHALL BE BENT COLD UNLESS OTHERWISE PERMITTED BY THE STRUCTURAL ENGINEER.
- REINFORCEMENT PARTIALLY EMBEDDED IN CONCRETE SHALL NOT BE FILLED BENT, EXCEPT AS SHOWN IN THE DESIGN DRAWINGS OR PERMITTED BY THE STRUCTURAL ENGINEER.
- TIES & CLOSE STIRRUPS MUST BE BENT AT 135°.


| BAR SIZE (DEFORMED) | TABLE 'A' TENSION BARS EMBEDMENT LENGTHS AND LAPPED SPICES IN MILLIMETERS | | TABLE 'B' COMPRESSION BARS EMBEDMENT LENGTHS AND LAPPED SPICES IN MILLIMETERS | |
|---------------------|---|-----------------------------------|---|-----------------------------------|
| | l _c = 20.7MPa(3000psi) | l _c = 27.6MPa(4000psi) | l _c = 20.7MPa(3000psi) | l _c = 27.6MPa(4000psi) |
| 10mm # | 300 | 300 | 300 | 300 |
| 12mm # | 300 | 300 | 300 | 300 |
| 16mm # | 300 | 400 | 300 | 400 |
| 20mm # | 400 | 550 | 350 | 500 |
| 25mm # | 600 | 800 | 550 | 750 |
| 28mm # | 750 | 1000 | 850 | 875 |
| 32mm # | 950 | 1300 | 850 | 1100 |

| BAR SIZE (DEFORMED) | TABLE 'A' TENSION BARS EMBEDMENT LENGTHS AND LAPPED SPICES IN MILLIMETERS | | TABLE 'B' COMPRESSION BARS EMBEDMENT LENGTHS AND LAPPED SPICES IN MILLIMETERS | |
|---------------------|---|-----------------------------------|---|-----------------------------------|
| | l _c = 20.7MPa(3000psi) | l _c = 27.6MPa(4000psi) | l _c = 20.7MPa(3000psi) | l _c = 27.6MPa(4000psi) |
| 10mm # | 225 | 300 | 200 | 300 |
| 12mm # | 275 | 300 | 250 | 300 |
| 16mm # | 350 | 400 | 325 | 400 |
| 20mm # | 450 | 500 | 475 | 500 |
| 25mm # | 550 | 625 | 550 | 625 |
| 28mm # | 625 | 675 | 625 | 675 |
| 32mm # | 700 | 775 | 700 | 775 |

NOTE: TOP PLAN BARS, MULTIPLY VALUE BY 2


NOTE: TOP PLAN BARS, MULTIPLY VALUE BY 2. VALUES GIVEN ABOVE CAN ALSO BE USED FOR COLUMNS.

- IF THE BEAM REINFORCING BARS END IN A WALL THE CLEAR DISTANCE FROM THE BAR TO THE FARTHER FACE OF THE WALL NOT BE LESS THAN 25mm. EMBEDMENT LENGTH SHALL BE AS SHOWN IN A TABLE 'A' FOR TENSION BARS AND TABLE 'B' FOR COMPRESSION BARS UNLESS SPECIFIED IN PLAN. TOP BAR SHALL NOT BE SPICED WITHIN THE COLUMN OR WITHIN A DISTANCE TWICE THE MEMBER DEPTH FROM THE FACE OF THE COLUMN. AT LEAST TWO STIRRUPS SHALL BE PROVIDED AT ALL SPICES.
- IF THERE ARE TWO OR MORE LAYERS OF REINFORCING BARS, USE 25mm# BAR SEPARATORS SPACED AT 1/4 ON CENTER. IN NO CASE SHALL THERE BE LESS THAN TWO (2) SEPARATORS BETWEEN TWO LAYERS OF BARS.
- MINIMUM CONCRETE PROTECTION FOR REINFORCING BARS OR STEEL SHAPES SHALL BE AS SHOWN IN FIG. B-2 UNLESS SPECIFIED ELSEWHERE.

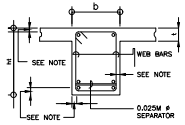

NOTE 1
20 mm CLEAR FOR JOIST
40 mm CLEAR FOR BEAMS
AND GIRDERS

FIG. B-2

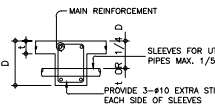

TYP. DET. FOR SLEEVES
THRU CONCRETE BEAM


FIG. B-3

- WHEN A BEAM CROSSES A GIRDER, REST BEAM ON TOP OF GIRDER BARS. BEAM REINFORCING BAR SHALL BE SYMMETRICAL ABOUT CENTER LINE WHENEVER POSSIBLE.
- GENERALLY NO SPICES SHALL BE PERMITTED AT POINTS WHERE CRITICAL BENDING STRESSES OCCUR. SPICES WHERE SO PERMITTED SHALL BE INDICATED IN THE TABLE 'A' AND 'B'. WELDED SPICES SHALL DEVELOP IN TENSION AT LEAST 125% OF THE SPECIFIED YIELD STRENGTH OF THE BAR. NOT MORE THAN 50% OF THE BARS AT ANY ONE SECTION IS ALLOWED TO BE SPICED THEREIN.


NOTES ON CONCRETE HOLLOW BLOCK WALLS

- UNLESS OTHERWISE SHOWN IN PLANS ALL CONCRETE HOLLOW BLOCKS AND CERAMIC BLOCKS SHALL BE REINFORCED AS INDICATED IN THE SCHEDULE OF CONCRETE HOLLOW BLOCKS AND CERAMIC BLOCK REINFORCEMENT.
- PROVIDE 150mm x 300mm STIFFENER COLUMN REINFORCED WITH 4-12mm WITH 6mm# TIES AT 150mm ON CENTER WHERE CONCRETE HOLLOW BLOCK TERMINATES AND AT EVERY 3.0M LENGTH OF CONCRETE HOLLOW BLOCK WALLS UNLESS NOTED IN STRUCTURAL PLANS.


| BLOCK THICKNESS | REINFORCEMENT | | NOTES |
|-----------------|-------------------|-------------------|---|
| | HORIZONTAL | VERTICAL | |
| 75 mm | 10mm @ 600mm O.C. | 10mm @ 600mm O.C. | A. MINIMUM LAPS AT SPICE = 0.25M B. PROVIDE ROOF ANGLE REINFORCEMENT AT CORNERS 0.92M LONG |
| 125 mm | 10mm @ 600mm O.C. | 10mm @ 600mm O.C. | C. WHERE CHB OR CER. BLK. WALL DOWELS JOIN COL. R.C. BEAMS AND WALL DOWELS WITH THE SAME SIZE AS VERT. OR HOR. REINFORCEMENTS SHALL BE PROVIDED |
| 150 mm | 10mm @ 600mm O.C. | 10mm @ 600mm O.C. | |
| 200 mm | 12mm @ 600mm O.C. | 12mm @ 600mm O.C. | |

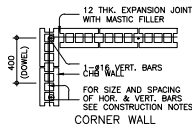


CORNER WALL

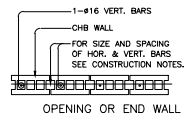


OPENING OR END WALL

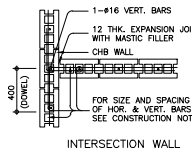


INTERSECTION WALL

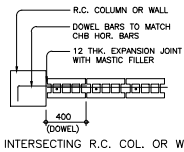

INTERSECTING R.C. COL. OR WALL

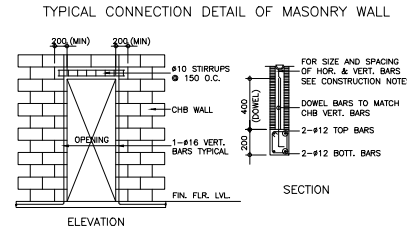


TYP. DET. OF LINTEL BEAM AT CHB WALL OPENING

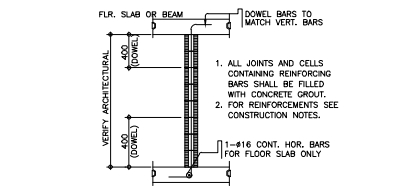

TYP. SECTION OF MASONRY PARTITION REINFORCEMENTS

TYPICAL CHB FOOTING DETAILS (WHERE APPLICABLE)

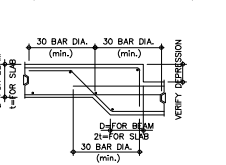


TYPICAL DETAIL FOR BEAM OR SLAB CHANGE SOFFIT

NOTES ON CONCRETE WALLS


- ALL WALLS SHALL BE REINFORCED ACCORDING TO THE FOLLOWING SCHEDULE OF WALL REINFORCEMENT UNLESS OTHERWISE INDICATED IN THE PLANS.

| WALL THICKNESS | REINFORCEMENT | | REMARKS | VERTICAL SECTION |
|----------------|--------------------|--------------------|--|------------------|
| | HORIZONTAL | VERTICAL | | |
| 100mm | #10mm @ 250mm O.C. | #10mm @ 300mm O.C. | HORIZONTAL BARS SHALL BE PLACED AT CENTERS VERTICAL. | VERT. BARS |
| 125mm | #10mm @ 200mm O.C. | #10mm @ 250mm O.C. | AT CENTERS VERTICAL. | HORV. BARS |
| 150mm | #12mm @ 250mm O.C. | #12mm @ 300mm O.C. | BARS STAGGERED OUT | |

- REINFORCING BARS SHALL HAVE 25mm CLEAR CONCRETE COVER FROM FACE OF WALL EXCEPT FOR WALLS IN CONTACT WITH THE GROUND WHERE A MINIMUM OF 60mm SHALL BE PROVIDED, AND FOR EXPOSED FACES OF FORMED WALLS WHERE THE MINIMUM SHALL BE 50mm CLEAR.
- CARRY VERTICAL BARS AT LEAST 60mm ABOVE FLOOR LEVEL TO PROVIDE FOR SPICES WHEN NECESSARY STOP AT 50mm BELOW TOP SLAB OR SOLID BENCH WHERE THE WALL ENDS VERTICAL AND HORIZONTAL BARS SHALL BE SPICED BY LAPPING A DISTANCE EQUAL TO 30 DIAMETERS AND WIRE SECURELY WITH 16 G.I. WIRE PROVIDED THAT SPICES IN ADJACENT BARS ARE STAGGERED AT LEAST 1.50M O.C.
- UNLESS OTHERWISE NOTED IN THE PLANS, ALL OPENINGS IN WALLS 250mm OR THICKER SHALL BE REINFORCED AROUND WITH 2-20mm# BARS FOR 225mm, 200mm, 175mm, 150mm, USE 2-16mm# FOR 125mm AND 100mm WALLS, USE 2-12mm# BARS. ALL WALLS SPANNING SHALL HAVE VERTICAL REINFORCEMENT BENT TO A U-FORM LIKE STIRRUPS AND SPACED ACCORDING TO THE SCHEDULE UNLESS OTHERWISE NOTED (SEE FIG.1)

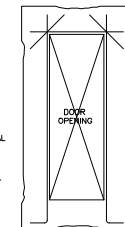


TYPICAL SLAB & BEAM CONSTRUCTION JOINT DET.

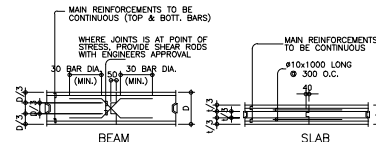


TYPICAL SLAB & BEAM CONSTRUCTION JOINT DET.

| BAR SIZE (DEFORMED) | DIAMETER (mm) | 180° END HOOK | | 90° END HOOK | |
|---------------------|---------------|---------------|-----|--------------|-----|
| | | D+2d | L | L | L |
| 10mm # | 60 | 75 | 125 | 150 | 150 |
| 12mm # | 75 | 100 | 150 | 200 | 200 |
| 16mm # | 95 | 125 | 175 | 250 | 250 |
| 20mm # | 115 | 150 | 200 | 300 | 300 |
| 25mm # | 150 | 200 | 250 | 350 | 450 |
| 28mm # | 240 | 300 | 300 | 500 | 500 |
| 32mm # | 300 | 335 | 450 | 600 | 600 |

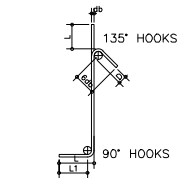

TYPICAL SLAB & BEAM CONSTRUCTION JOINT DET.

| BAR SIZE (DEFORMED) | DIAMETER (mm) | 180° HOOK | | 90° HOOK | |
|---------------------|---------------|-----------|-----|----------|-----|
| | | D+2d | L | L | L |
| 10mm # | 40 | 125 | 85 | 100 | 100 |
| 12mm # | 50 | 165 | 115 | 115 | 115 |
| 16mm # | 65 | 200 | 140 | 150 | 150 |
| 20mm # | 115 | 250 | 165 | 300 | 300 |
| 25mm # | 150 | 365 | 230 | 405 | 405 |

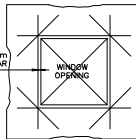

TYPICAL SLAB & BEAM CONSTRUCTION JOINT DET.



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AR. SARAH JANE G. HERNANI, uap
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PROJECT TITLE:

PROPOSED HAZARDOUS WASTE STORAGE FACILITY AT SOGOD CAMPUS

LOCATION: SLSU-MAIN CAMPUS, SAN ROQUE, SOGOD SOUTHERN LEYTE

OWNER:

SOUTHERN LEYTE STATE UNIVERSITY

ADDRESS: SOGOD SOUTHERN LEYTE

APPROVED AS PER PLAN:


PROSE IVY G. YEPES, Ed.D
UNIVERSITY PRESIDENT

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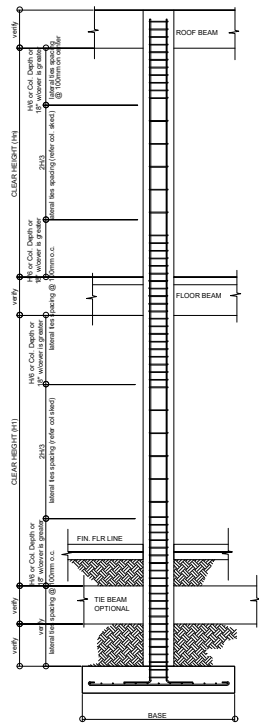
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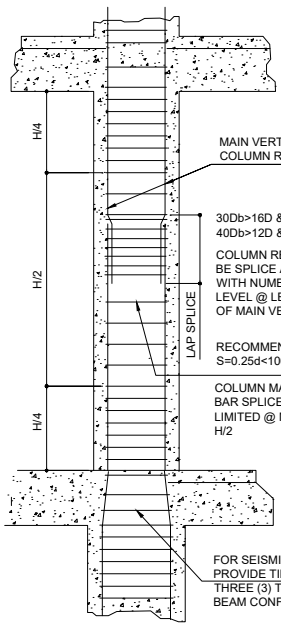
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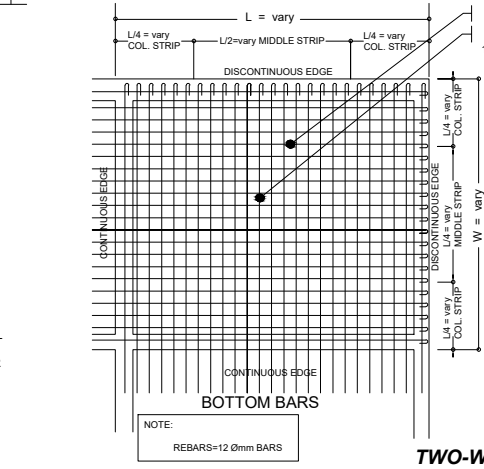
TYPICAL BEAM ELEVATION



TYPICAL COLUMN ELEVATION


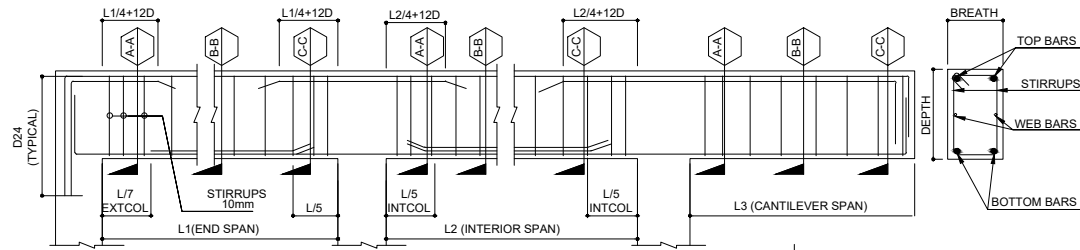


TYPICAL COLUMN ELEVATION



TWO-WAY SLAB DETAIL

NOT TO SCALE

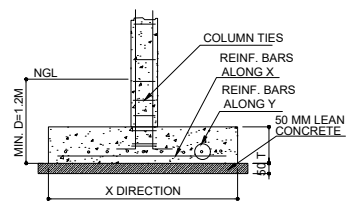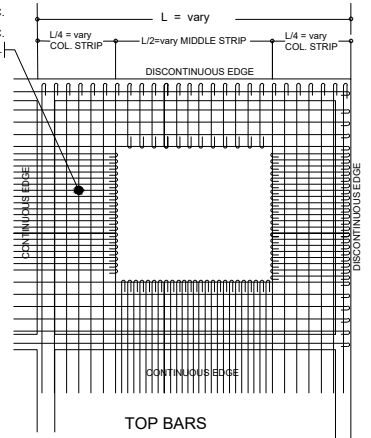

TYPICAL FOOTING DETAIL



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